


Safety is a Part
of Your Contract


GENERAL NOTES:

1. ALL REFERENCES TO WALL LINE (W/L) REFER TO THE CENTERLINE OF THE EXISTING SHEET PILE WALL ON THE ORLEANS LEVEE OF THE 17TH STREET CANAL. STATIONING ALONG THE WALL IS BASED ON THE THEORETICAL WIDTH OF THE SHEETS (BZ12.1L AND HOESCH 12 ARE 22.64'; PMA-22 IS 19.625').
2. ELEVATIONS REFER TO NATIONAL GEODETIC VERTICAL DATUM (N.G.V.D.). ELEVATION AT U.S.C.E. MONUMENT 14 IS 8.77 N.G.V.D..
3. NORMAL WATER SURFACE ELEVATION RANGE IS FROM EL.1.5 TO EL.2.0 (N.G.V.D.).
4. REFERENCES TO THE PROTECTED SIDE OF THE LEVEE REFER TO THE LAND SIDE OF THE LEVEE. REFERENCES TO THE FLOOD SIDE OF THE LEVEE REFER TO THE CANAL OR LAKE SIDE OF THE LEVEE.
5. THE CONTRACTOR SHALL REMOVE THE COAL TAR EPOXY PAINT FROM THE EXISTING SHEET PILE AS SPECIFIED IN 'STEEL SHEET PILING' OF THE SPECIFICATIONS.
6. THE CONTRACTOR SHALL NOTE THE CLOSE PROXIMITY OF RESIDENCES, TREES, AND UTILITIES ALONG THE ENTIRE LENGTH OF THE PROJECT SITE. HE SHALL EXERCISE EXTREME CAUTION AT ALL TIMES WHEN WORKING ON THE LEVEE AND HE SHALL BE RESPONSIBLE FOR THE REPAIR OF ANY DAMAGE RESULTING FROM HIS OPERATIONS.
7. CONTRACTOR SHALL PROVIDE, ERECT, AND MAINTAIN A SAFETY FENCE AROUND THE CONSTRUCTION RIGHT-OF-WAY. SEE SPECIAL CLAUSE 'SAFETY PROVISIONS'.
8. SEE DRAWING 5 FOR BENCH MARK INFORMATION.

OBSTRUCTIONS TO R/W		
W/L STATION (APPROXIMATE)	ITEM AND OWNER	DISPOSITION
99+71	U.S. SPRINT FIBER OPTIC LINE	DWG. NO. 2
35+82	L.P. & L. POWER LINE	DWG. NO. 4

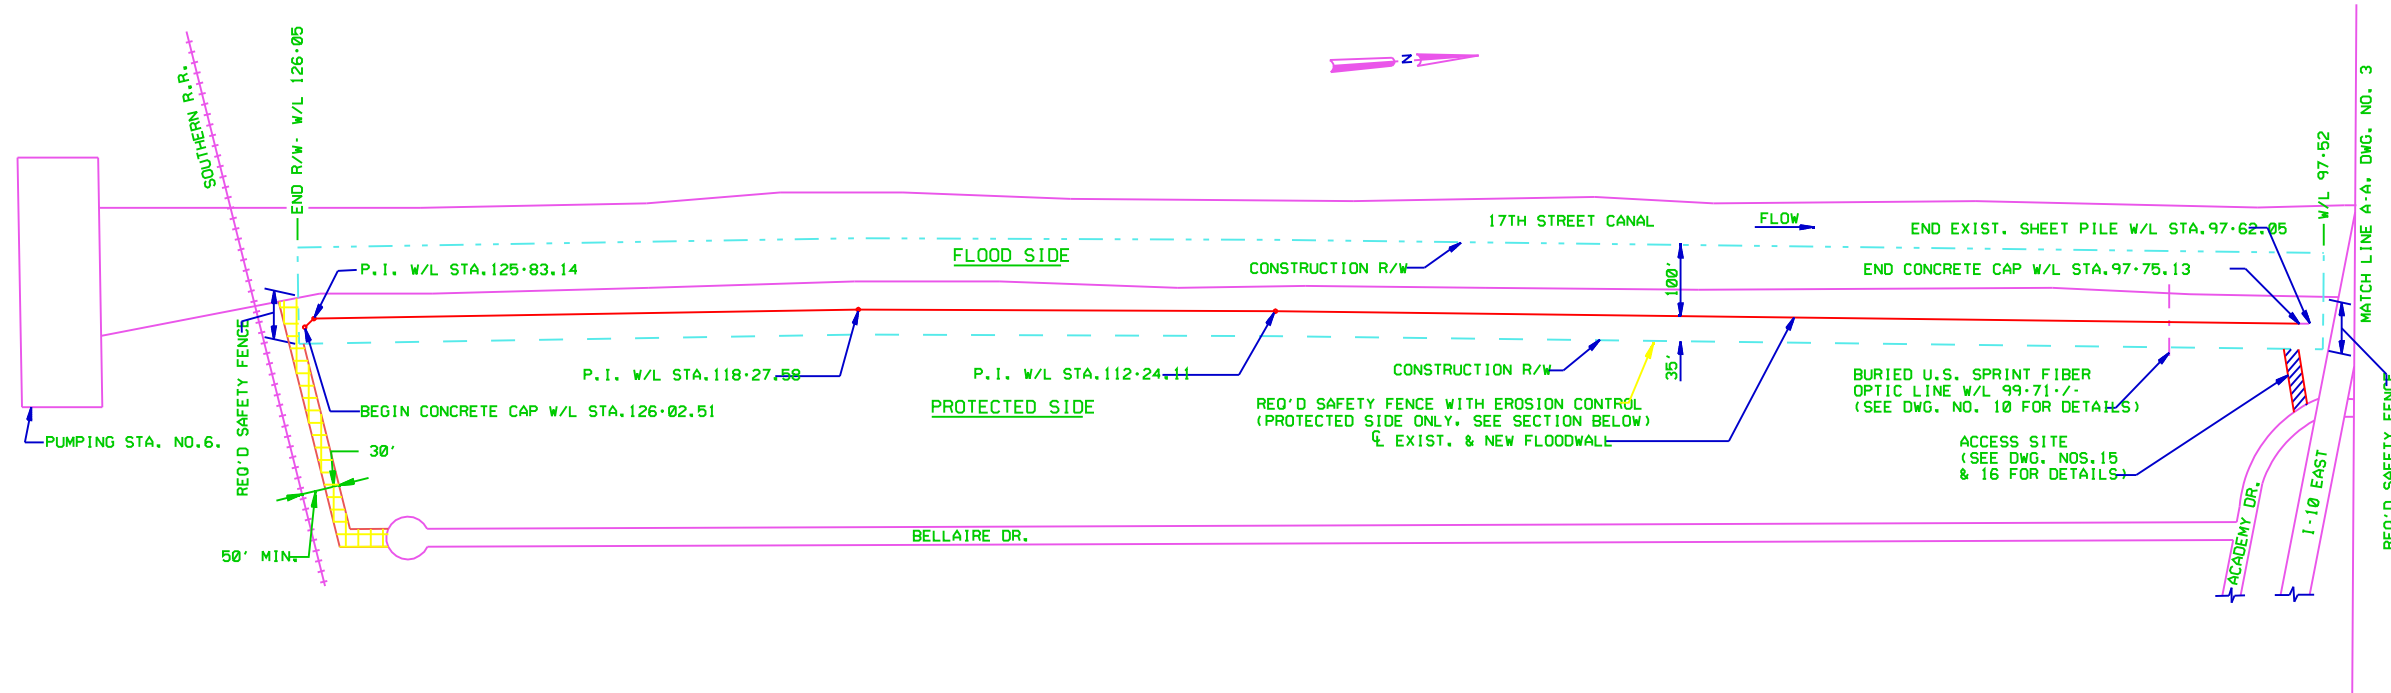

PLAN
SCALE 1" = 100'-0"

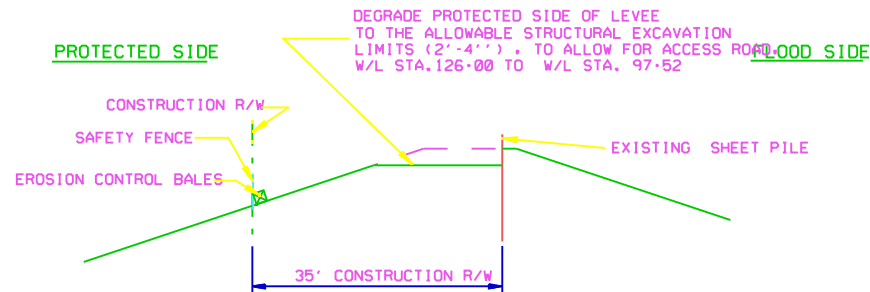

EXCAVATED MATERIAL MUST BE HAULED IN ACCORDANCE WITH C2C OF THE SPECIFICATIONS AND STORED FOR REUSE IN ACCORDANCE WITH SPECIAL CLAUSE "OFFSITE STORAGE".

STA. 116+00 TO STA. 98+00 SHOWN. OTHERS AREAS SIMILAR.

ACCESS AND STORAGE DETAILS

STA. 126+03 TO STA. 97+52
SCALE 1" = 10'-0"
ACCESS NOT SHOWN FOR CLARITY

LEGEND

- SHEET PILE TO BE CAPPED
- SHEET PILE LEFT UNCAPPED
- CONSTRUCTION R/W
- UTILITY
- CONSTR. R/W, SAFETY FENCE, EROSION CONTROL
- CONSTR. R/W AND SAFETY FENCE

SCALE: 1" = 100'

100' 0 100' 200' 300' 400'

SCALE: 1" = 10'

10' 0 10' 20' 30' 40'

SYMBOL	DESCRIPTION	DATE	APPROVED
REVISIONS			
U.S. ARMY ENGINEER DISTRICT, NEW ORLEANS			
CORPS OF ENGINEERS			
NEW ORLEANS, LOUISIANA			
BOARD OF LEVEE COMMISSIONERS ORLEANS LEVEE DISTRICT NEW ORLEANS, LOUISIANA		MODJESKI & MASTERS INC. NEW ORLEANS, LOUISIANA	
LAKE PONTCHARTRAIN, LA. AND VICINITY			
HIGH LEVEL PLAN			
17TH STREET CANAL			
EXCAVATION AND FLOODWALL PROTECTION			
CAPPING OF FLOODWALLS			
EAST SIDE LEVEE IMPROVEMENTS			
PLAN-1 AND GENERAL NOTES			
DESIGNED BY: F.S.	DATE: NOV. 1992	PLOT SCALE: 1200	PLOT DATE: APR 1993
DRAWN BY: P.M.R.	CADD FILE: 48000082.DWG	FILE NO.	H-4-40208
CHECKED BY: M.L.S.	SOLICITATION NO.	DWG.	2 OF 16
SUBMITTED BY: M. B. CONWAY	MODJESKI & MASTERS INC.		
DESIGN ENGINEER	DACW29-93-B-0025		

